

- GENERAL NOTES:**
1. ALL DIMENSIONS IN CABINETS TO BE CALLED AND RECALLED
 2. CONTRACTOR IS RESPONSIBLE FOR PROTECTING ALL EXISTING CONCRETE FLOOR AND GLASS CURB CONSTRUCTION.
 3. SEE EQUIPMENT PLAN - SHEET A-12 FOR ALL TYPES OF PLAN OR MEASUREMENTS AND 1/4" = 1'-0"
 4. TO DIRECT STRUCTURAL QUESTIONS TO ARCHITECT BETWEEN REPRESENTATION PERIODS, PLEASE CALL ARCHITECT.
 5. TAPE ONLY ON GYPSUM BOARD ON UNFURNISHED FLOOR. DO NOT SEAL THE FLOOR IN THE BEVERAGE COOLER & THE BEER COOLER AREAS.
- REFERENCED NOTES:**
1. UNDERGROUND IRRIGATION SYSTEM CONTROL BOX BY GENERAL CONTRACTOR (SEE SPECIFICATIONS)
 2. 8'-0" HIGH CHAIN LINK FENCE, SEE ELEVATIONS.
 3. HAND SINK, SEE PLUMBING DRAWINGS.
 4. CANTYNE HOOD DRAIN AND PIPES JOISTS BELOW FINISHED FLOOR, SEE AREA SITE PLAN FOR INFORMATION. PROVIDE MEAT TRACE TRAP PIPE, SEE ELECTRICAL & PLUMBING DRAWINGS.
 5. EXTERIOR CONCRETE OVERLAP SEE SITE PLAN AND CIVIL DRAWINGS.
 6. ELECTRICAL COPES CONDUITS FOR CASH DRAW, SEE ELECTRICAL DRAWINGS.
 7. CONDUIT TO REMOVE CONDENSING WITH LONG SLEEP.
 8. GAS RETIRE, SEE CIVIL, UTILITY, MECHANICAL & PLUMBING DRAWINGS.
 9. 8'-0" HIGH GATE, SEE DOOR SCHEDULE.
 10. REPAIR EXISTING LANTERN, SEE ELECTRICAL DRAWINGS.
 11. STEEL COLUMN, SEE STRUCTURAL DRAWINGS.
 12. STEEL COLUMN, SEE PLUMBING & SANITARY DRAWINGS. STAINLESS STEEL FLOOR SINK SURROUND WITH CROWN FLANGE OVER FLOOR SINK, SEE DETAIL WA-10 TYP.
 13. FLOOR SINK WITH GRATE, SEE PLUMBING AND SANITARY DRAWINGS FOR FABRICATION. ALSO 1/2" TOP OF TILE COMPARTMENT AND SEE EQUIPMENT PLAN.
 14. VENTROOF (CHINA & SPOON) WALL MOUNTED WITH ACCESSIBILITY SYMBOLS.
 15. USE OF VALANCE ABOVE SEE DETAILS ABA-11 & 12. SUPPORT BLOCKING, CANT AS REQUIRED FOR FURNITURE.
 16. TRAPING FOR 8" RAISED FLOOR AT CASH DRAW, SEE DETAIL WA-13.
 17. FINISH FLOOR SHALL BE ALIGNED WITH OTHER NUMBER TO SUPPORT THE SIGN, SEE STRUCTURE & BUILDING PLAN. METEOROLOGICAL FLOOR OUT PROTECT TOP OF FLOOR, SEE DETAIL WA-11.
 18. SOLID SURFACE SINK, SEE WA-11.
 19. THESE DOORS SHALL HAVE LOCKS.
 20. 1/2" AIR GAP, SEE 40" TALL TO PREVENT BACKFLOW. PRESSURE REDUCING VALVE AND MAIN WATER SHUTOFF, PRESSURE REDUCING VALVE, SEE PLUMBING DRAWINGS.
 21. PRESSURE REDUCING VALVE, SEE PLUMBING DRAWINGS.
 22. FIREPROOF (SHOCK PRATING) SYSTEM, SEE SHOCK PRATING SCHEDULE OF SHEET A-11.
 23. LOCKDOWN ENTRY DOOR, PROVIDE THRESHOLD, SEE DOOR SCHEDULE.
 24. 1/2" AIR GAP, SEE 40" TALL TO PREVENT BACKFLOW. PRESSURE REDUCING VALVE AND MAIN WATER SHUTOFF, PRESSURE REDUCING VALVE, SEE PLUMBING DRAWINGS.
 25. BACK DAMPED LINES REPRESENT CHANGES TO SINK, OVER GREEN DASH AND, SEE DETAIL WA-11.
 26. COLORED CONCRETE FLOOR, SEE PROHIBITION SCHEDULE - COLOR CO-1.
 27. RESILIENT RUBBER FLOOR TILE, REFER TO FLOOR MATERIAL SCHEDULE.
 28. HORIZONTAL REINFORCED PANEL (RTP), BY VERTICAL, SEE FROM SCHEDULE, BRUSH AS A THICK LINE.
 29. 1/2" AIR GAP, SEE 40" TALL TO PREVENT BACKFLOW. PRESSURE REDUCING VALVE AND MAIN WATER SHUTOFF, PRESSURE REDUCING VALVE, SEE PLUMBING DRAWINGS.
 30. CENTER PROVIDED UNDER COUNTER CARRY DISPLAY UNIT, SEE CASH DRAW CABINET INSTALLS.
 31. 1/2" AIR GAP, SEE 40" TALL TO PREVENT BACKFLOW. PRESSURE REDUCING VALVE AND MAIN WATER SHUTOFF, PRESSURE REDUCING VALVE, SEE PLUMBING DRAWINGS.
 32. HOT WATER HEATER, SEE PLUMBING DRAWINGS.
 33. BEER COOLER DRAIN LINE, SEE PLUMBING DRAWINGS.
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FLOOR PLAN
 A-12 SCALE: 1/4" = 1'-0"

SCANNED

RECEIVED
 FEB 8 2014
 IDAHO STATE POLICE
 ALCOHOL BEVERAGE CONTROL
 IDAHO STATE POLICE
 ALCOHOL BEVERAGE CONTROL

NOTE
 This document should not be separated or altered in part or in whole. It is the responsibility of the contractor to ensure that all portions of the documents that apply to the work covered by the contract. The contractor shall be responsible for any omissions or errors that may occur in the course of the project. The contractor shall be responsible for any omissions or errors that may occur in the course of the project. The contractor shall be responsible for any omissions or errors that may occur in the course of the project.

ADVENTURE'S FIRST STOP
MAVERIK
 STORE # 485
Maverik, Inc.
 Rebuild of Store #211
 3080 S. Five Mile Rd.
 Boise, ID 83709

CONSTRUCTION DOCUMENTS


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1	11-08-2013	CITY COMMENTS

ISSUE: December 3, 2013
 PROJECT NO: M3016
 DRAWN BY: KJM/BAM
 CHECKED BY: TA

SHEET TITLE

FLOOR PLAN
 A-12
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SCANNED

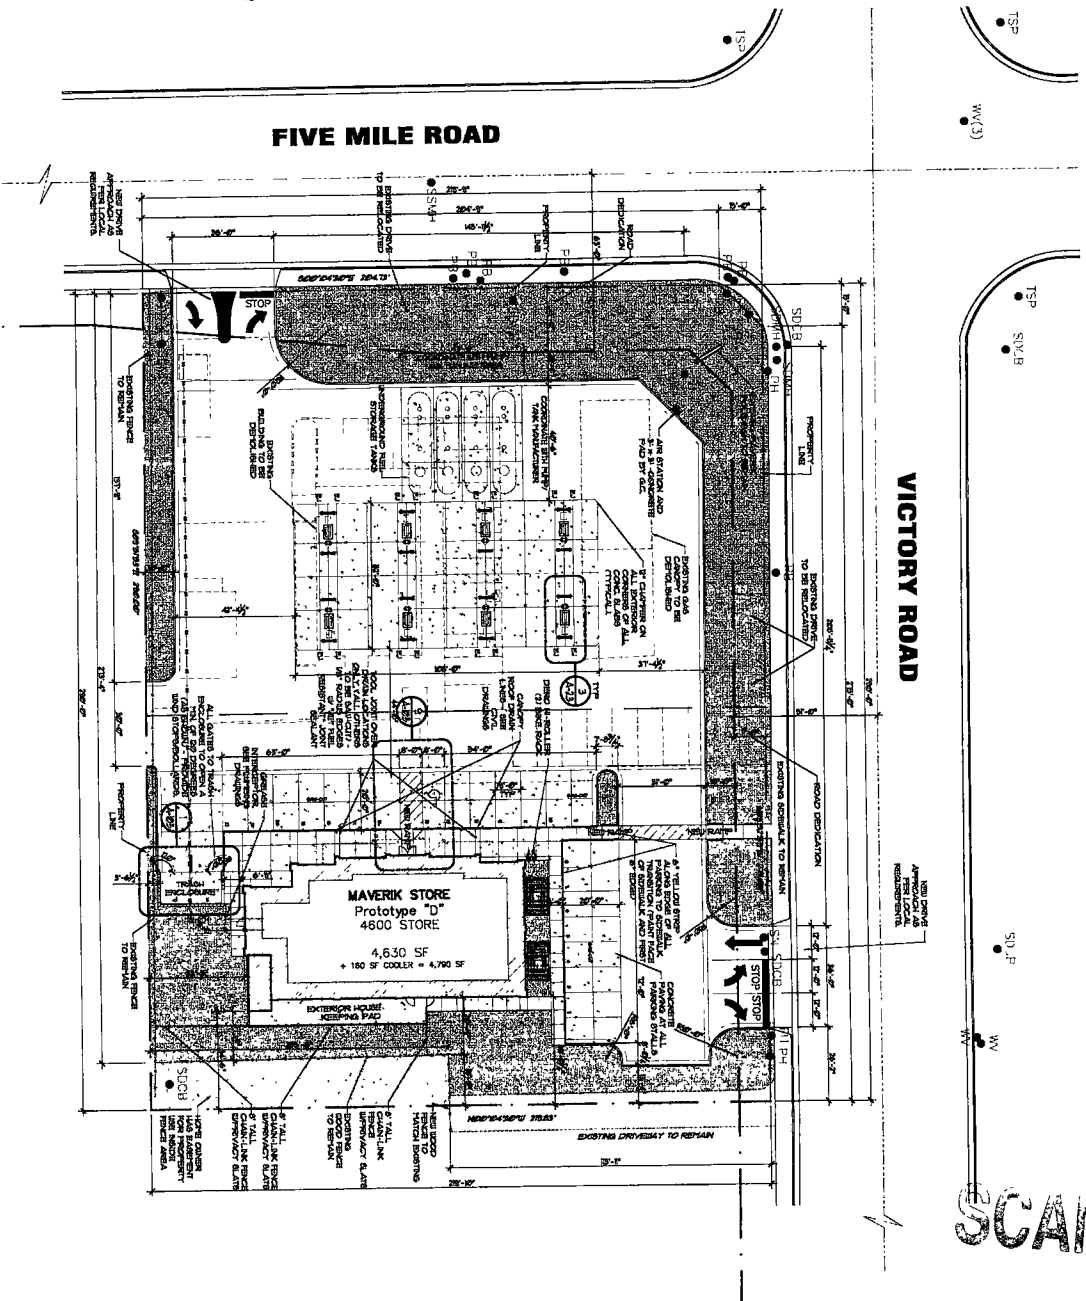

ARCHITECTURAL SITE PLAN
SCALE: 1" = 20'-0"

GENERAL NOTES

1. SEE CIVIL DRAWINGS FOR ALL UTILITIES TO THE BUILDING.
2. REFER TO CIVIL DRAWINGS FOR GRADE AND SITE ELEVATIONS.
3. REFER TO CIVIL DRAWINGS FOR ANY DETENTION AREAS AND REQUIREMENTS AS WELL AS ANY DRAINAGE ISSUES.
4. ALL UTILITY DIGGING OR OTHER EXCAVATION SHALL TAKE IN CONSIDERATION EXISTING UTILITIES, CURED AND UNCURED CONCRETE, AND OTHER STRUCTURES AND SHALL BE REPLACED AS PART OF THE G.C. BID.
5. REFER TO CITY STATE AND DOT STANDARDS FOR ANY STANDARDS ON APPROACH REQUIREMENTS.
6. CONCRETE, REINFORCING, AND SUBGRADE MATERIALS PER MAVERIK, INC. THESE SHALL BE NORDERED ONLY IF REQUIRED BY THE SOILS REPORT. REFER TO SOILS REPORT FOR ANY THICKNESS NOT PRECISED BELOW.
- 6.1. SUBGRADE - 4" THICK WITH 6"x6" W/4X4 WELD LINE REBAR AND (2) 1/4" TOP AND BOTTOM ON THICKENED EDGE WHERE OCCURS. SEE DETAIL 6 & 7/AS4 AND "W/4X4 WELD LINE" ON C6.
- INTERIOR SLAB - 8" THICK WITH STEEL REINFORCEMENT COVER 9" GRAVEL, SEE STRUCTURAL DRAWINGS.
- PARKING AREAS - 6" THICK WITH FIBER REINFORCEMENT OVER GRANULAR FILL.
- 6.1.6 CANOPY - 4" THICK WITH REBAR REINFORCEMENT OVER GRANULAR FILL.
- UNDERGROUND STORAGE TANKS - 12" THICK WITH 4 BARS AT 17" O.C. BOTH WAVES.
- TRASH ENCLOSURE - 6" THICK WITH REBAR REINFORCEMENT OVER 4" GRANULAR FILL.

1. ASPHALT THICKNESSES SHALL BE AS SPECIFIED IN THE SOILS REPORT. THE HEAVIEST DUTY DESIGN SHALL BE UTILIZED THROUGHOUT THE SITE.

LEGEND:

- HATCH REPRESENTS LANDSCAPED AREAS. SEE PLANNING PLAN.
- HATCH REPRESENTS CONCRETE AREAS.

SITE DATA

PARKING:	29 STALLS PROVIDED (1 ADA)
BUILDING AREA:	4,630 SF.
PARCEL AREA:	54,517 SF. (1.25 ACRES)
LANDSCAPE:	10,981 SF. (25% OF SITE)
ASPHALT:	21,989 SF. (53% ACRES)

RECEIVED
FEB 18 2014
IDAHO STATE POLICE
ALCOHOL BEVERAGE CONTROL

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ARCHITECTURAL SITE PLAN

A-0.0
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